PLANS TO SITE PLAN REVIEW OF PROPOSED GARAGE

AT

119 CRANBERRY HIGHWAY

N

BOURNE, MASSACHUSETTS





DESIGNED AND PREPARED BY



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SEPTEMBER 22, 2023 REVISED THROUGH JANUARY 22, 2024


NOTES:

- THE PURPOSE OF THIS PLAN SET IS TO ACCOMPANY
 AN APPLICATION FOR SITE PLAN REVIEW -- SPECIAL
 PERMIT
- SITE PLAN SPECIAL PERMIT APPROVAL IS REQUIR FOR CONSTRUCTION OF ANY COMMERCIAL STRUCTURE PER BOURNE ZONING BYLAW SECTION 1233.
- 3. THE FOLLOWING PLANS DEMONSTRATE COMPLIANCE WITH THE APPLICABLE STANDARDS SET FORTH IN THE TOWN OF BOURNE ZONING BYLAWS


SCHEDULE OF DRAWINGS			
SHEET ID	PLAN TITLE		
1	COVER SHEET		
1	EXISTING CONDITIONS		
2	SITE PLAN		
3	LANDSCAPE & LIGHTING PLAN		
4	DETAILS		
5	TRUCK TURNING PLAN		

REQUESTED WAIVERS:


1. WAIVER FOR USE OF OVERHEAD WIRES (SECTION 1238. A.3.E)

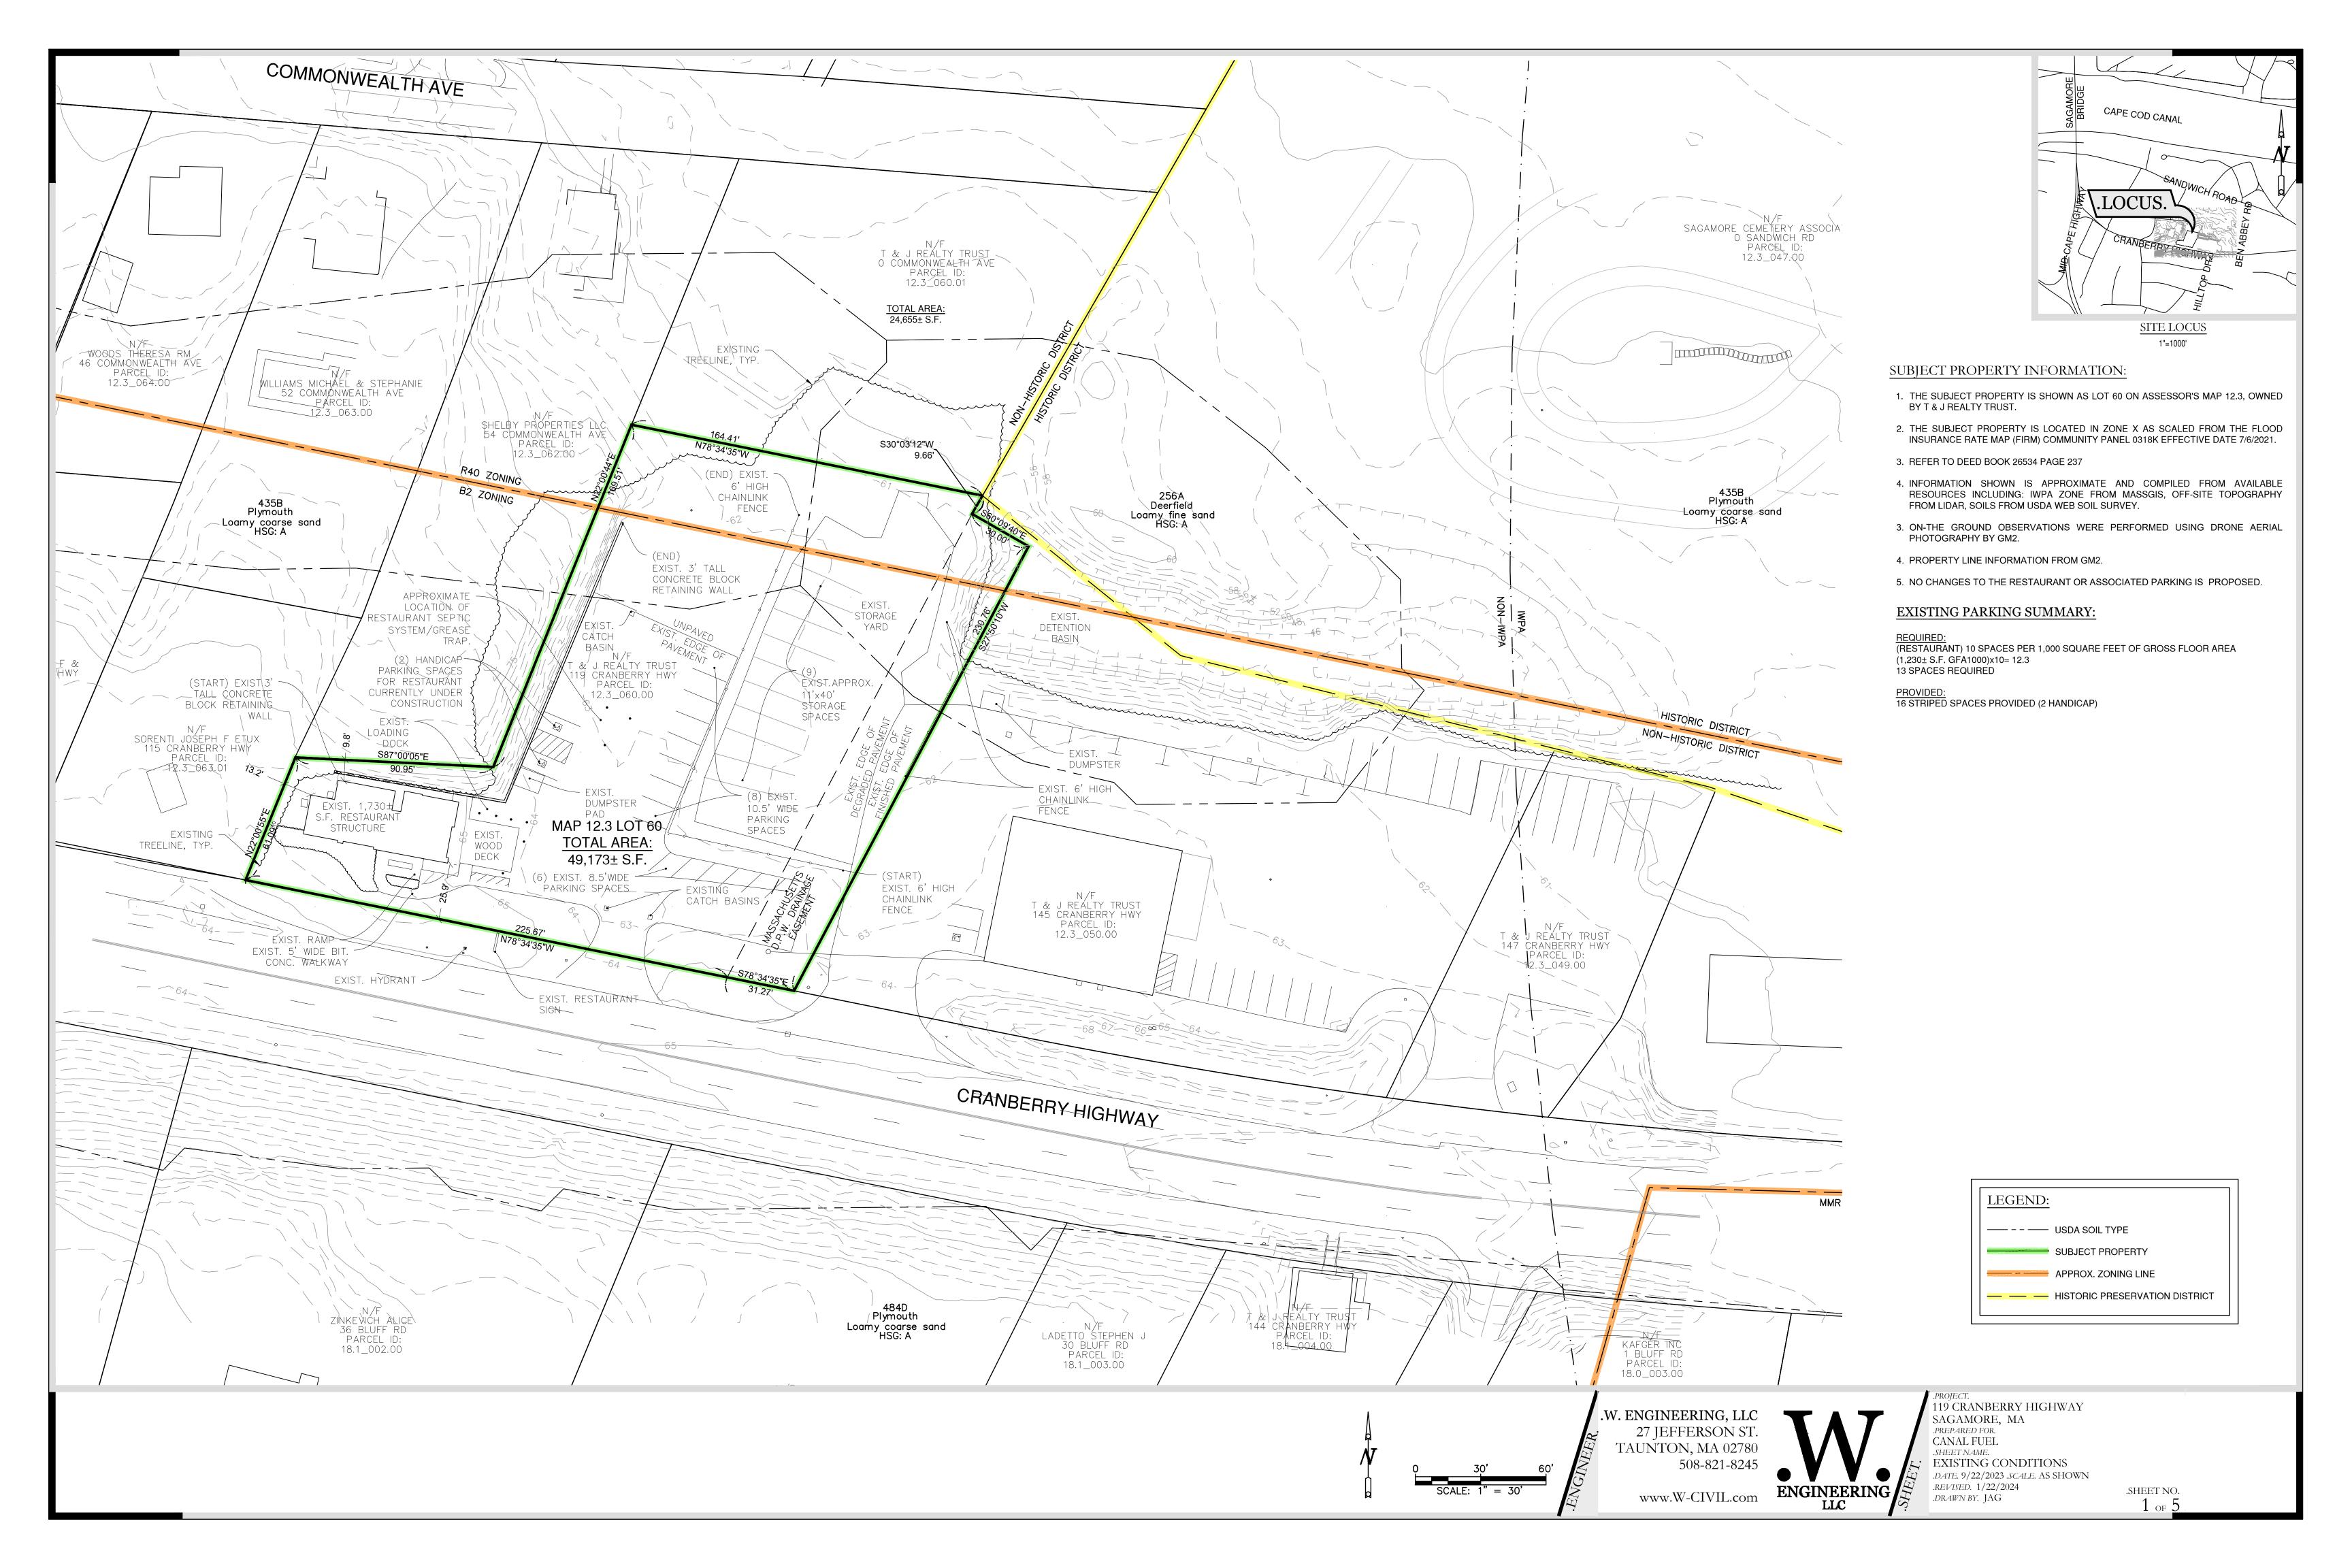



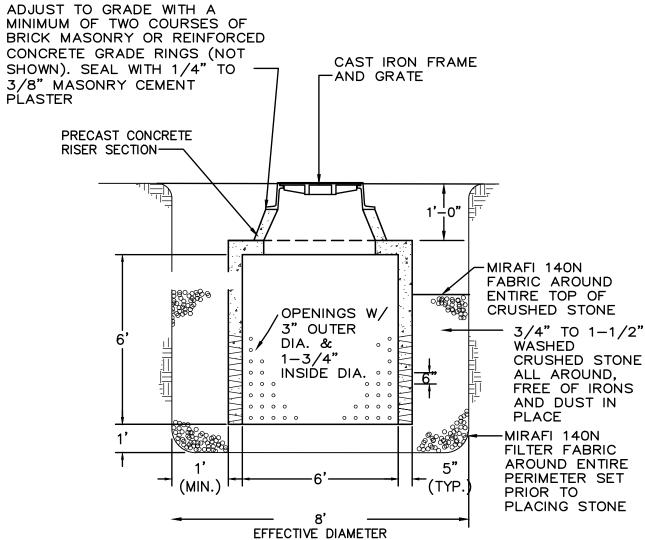

LEACHING CATCH BASIN NOT TO SCALE

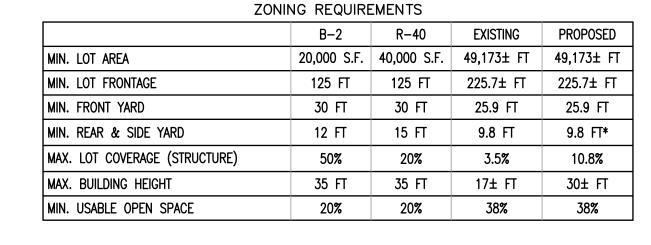

*EXISTING NON-CONFORMING

ADDITIONAL ZONING NOTES

2130: DIVIDED LOT. WHERE A DISTRICT BOUNDARY LINE DIVIDES ANY LOT EXISTING AT THE TIME SUCH LINE IS ADOPTED, THE REGULATIONS FOR ANY DISTRICT IN WHICH THE LOT HAS FRONTAGE ON A STREET MAY BE EXTENDED NOT MORE THAN 30 FEET INTO THE OTHER DISTRICT BY SPECIAL PERMIT OF THE PLANNING BOARD.

SITE PLAN REVIEW CHECKLIST NOTES:

- 1. LOCATION & BOUNDARIES
- SHOWN ON EXISTING CONDITIONS & PROPOSED SITE PLAN.
- 2. ADJACENT STREETS & WAYS
- SHOWN ON LOCUS, EXISTING CONDITIONS & PROPOSED SITE PLAN.

ON-SITE TOPOGRAPHY FROM DRONE AERIAL PHOTOGRAPHY SHOWN IN 1 FOOT CONTOURS BY GM2. OFF-SITE TOPOGRAPHY FROM LIDAR SHOWN IN 2 FOOT CONTOURS. NO SIGNIFICANT GRADING IS PROPOSED.

4. EXISTING & PROPOSED VEGETATION

EXISTING VEGETATION DESCRIBED ON EXISTING CONDITIONS PLAN AND THE LANDSCAPE PLAN (DETAIL SHEET). NO VEGETATION REMOVAL OR PLANTING IS PROPOSED.

5. STRUCTURES

EXISTING RESTAURANT STRUCTURE AND PROPOSED STORAGE GARAGE ARE SHOWN ON THE PROPOSED SITE PLAN.

6. DRIVES/ACCESS/EGRESS

ACCESS TO PROPOSED GARAGE SHALL CONTINUE TO BE VIA THE EXISTING DRIVE AT 145 CRANBERRY HIGHWAY.

7. WALKWAYS THE EXISTING WALKWAY ASSOCIATED WITH THE RESTAURANT IS SHOWN ON THE EXISTING SITE PLAN. NO NEW WALKWAYS ARE PROPOSED.

EXISTING PARKING SUMMARY IS SHOWN ON THE EXISTING CONDITIONS PLAN. PROPOSED PARKING SUMMARY IS SHOWN BELOW ON THIS SHEET.

9. LOADING AREAS

PROPOSED LOADING AREA SHOWN ON THE PROPOSED SITE PLAN. EXISTING RESTAURANT LOADING AREA SHOWN ON THE EXISTING CONDITIONS PLAN.

10. SCREENING

THE PROPOSED BUILDING IS SET BACK 144.2'. WHILE NOT REQUIRED, EXTENSIVE PLANTINGS ARE PROPOSED ALONG THE FRONTAGE INCLUDING EVERGREEN SCREENING OF THE PROPOSED GARAGE. EXISTING PARKING AREA ASSOCIATED WITH RESTAURANT IS SCREENED BY 3' HIGH CONCRETE BLOCK WALL AND 6' HIGH EARTHEN BERM AS SHOWN ON THE EXISTING CONDITIONS PLAN. ABUTTING PROPERTY TO NORTH OF PROPOSED BUILDING IS UNDER COMMON OWNERSHIP.

11. WATER SUPPLY NO NEW WATER SUPPLY OR CONNECTION IS PROPOSED.

12. SANITARY SEWERAGE

NO NEW SANITARY SEWERAGE CONNECTION IS PROPOSED. (BATHROOM FACILITIES ARE LOCATED AT 145 CRANBERRY HIGHWAY.)

13. STORM DRAINAGE

NO NEW STORM DRAINAGE STRUCTURES ARE PROPOSED. NO INCREASE OF IMPERVIOUS AREA IS PROPOSED.

14. UTILITIES

THE PROPOSED ELECTRIC CONNECTION IS SHOWN ON THE PROPOSED SITE PLAN. NO OTHER NEW UTILITY CONNECTIONS ARE PROPOSED.

15. WASTE CONTROL

THE PROPOSED STORAGE GARAGE WILL NOT GENERATE SUBSTANTIAL WASTE. EXISTING WASTE MANAGEMENT LOCATED AT 145 CRANBERRY HIGHWAY WILL BE

16. EROSION CONTROL

PROPOSED EROSION CONTROL IS SHOWN ON THE PROPOSED SITE PLAN.

NO NEW SIGNS ARE PROPOSED. THE EXISTING RESTAURANT SIGN LOCATION IS SHOWN ON THE EXISTING CONDITIONS PLAN.

18. LIGHTING PLAN NO NEW EXTERIOR LIGHTING IS PROPOSED. SEE LIGHTING PLAN AND NOTES ON THE

DETAIL SHEET.

19. LANDSCAPE PLAN

NO VEGETATION REMOVAL IS PROPOSED. SEE FRONTAGE LANDSCAPE PLAN ON SHEET

20. FLOOR PLANS

THE PROPOSED STORAGE GARAGE WILL BE OPEN. CONCEPTUAL FLOOR PLANS ARE SHOWN ON THE DETAIL SHEET.

21. ARCHITECTURAL ELEVATIONS

CONCEPTUAL ELEVATIONS ARE SHOWN ON THE DETAIL SHEET.

PROPOSED PARKING SUMMARY:

(EXISTING RESTAURANT) 10 SPACES PER 1,000 SQUARE FEET OF GROSS FLOOR AREA (1,230± S.F. GF/1000)x10= 12.3 SPACES

(PROPOSED WAREHOUSE, NO EMPLOYEES, NO OFFICE, NO PRODUCTION AREA) 1 SPACE PER 1,000 S.F. OF STORAGE AREA (3600 S.F./1000)= 3.6 SPACES

16 SPACES REQUIRED

16 EXISTING RESTAURANT PARKING SPACES PROVIDED (2 HANDICAP) 7 POTENTIAL FUTURE RESTAURANT SPACES (UNSTRIPED) 4 POTENTIAL FUTURE WAREHOUSE SPACES (UNSTRIPED)



119 CRANBERRY HIGHWAY SAGAMORE, MA .PREPARED FOR. CANAL FUEL .SHEET NAME. PROPOSED SITE PLAN .DATE. 9/22/2022 .SCALE. AS SHOWN .REVISED. 1/22/2024 .DRAWN BY. JAG

SHEET NO.

.W. ENGINEERING, LLC

SUBJECT PROPERTY

— — HISTORIC PRESERVATION DISTRICT

APPROX. ZONING LINE

LEGEND:


27 JEFFERSON ST. TAUNTON, MA 02780 508-821-8245



OVERALL LANDSCAPE PLAN* SCALE: 1"=40'

PLANTING SCHEDULE						
COMMON NAME	LATIN NAME	MIN. SIZE	KEY	QTY.		
TREES						
EASTERN WHITE PINE	PINUS STROBUS	4' HT.	PS	3		
LITTLELEAF LINDEN	TILIA CORDATA	2" CAL.	TC	3		

*IT IS IMPORTANT TO NOTE THAT THE PROPOSED WAREHOUSE WILL NOT RESULT IN A REQUIRED PARKING INCREASE OF SIX OR MORE SPACES. THEREFORE, THE LANDSCAPING AND SCREENING REQUIREMENTS SET FORTH IN 3500 ARE NOT APPLICABLE.

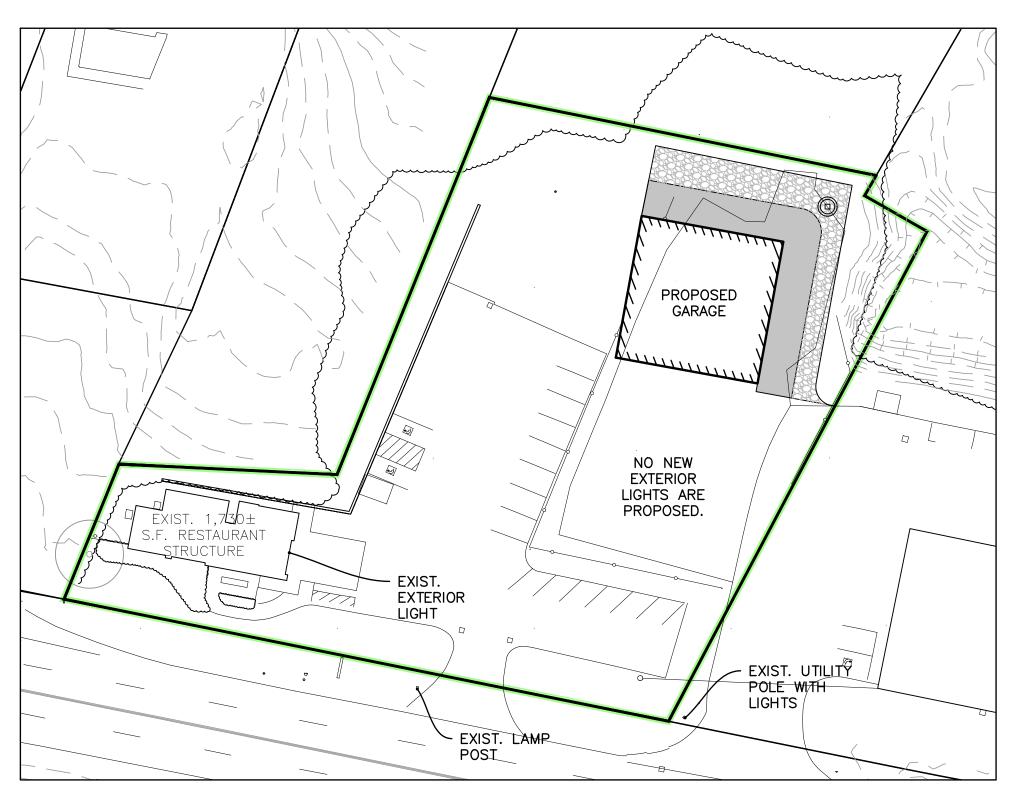



LIGHTING PLAN
SCALE: 1"=40'

LIGHTING NOTES:


NO NEW EXTERIOR LIGHTING IS CURRENTLY PROPOSED. ALL FUTURE LIGHTING SHALL MEET THE FOLLOWING REQUIREMENTS:

- A. PROPOSED GARAGE SHALL USE FULL CUTOFF LIGHT FIXTURES FOR EXTERIOR LIGHTING IN WHICH NO MORE THAN 2.5% OF THE TOTAL OUTPUT IS EMITTED AT 90 DEGREES FROM THE VERTICAL POLE OR BUILDING WALL ON WHICH IT IS MOUNTED.
- B. FLOOD, AREA AND UP-LIGHTING IS NOT ALLOWED.
- C. REFLECTORS AND SHIELDING SHALL BE PROVIDED TO MINIMIZE ALL LIGHT AT THE

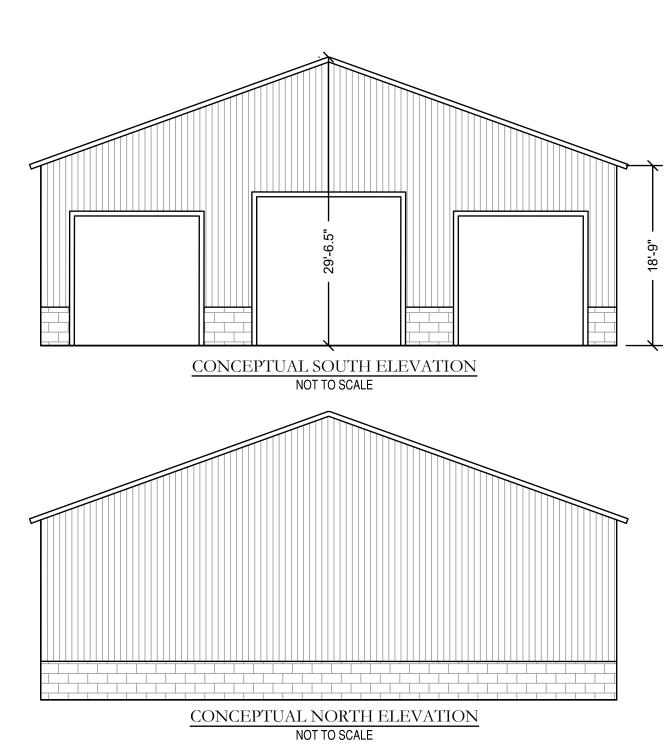


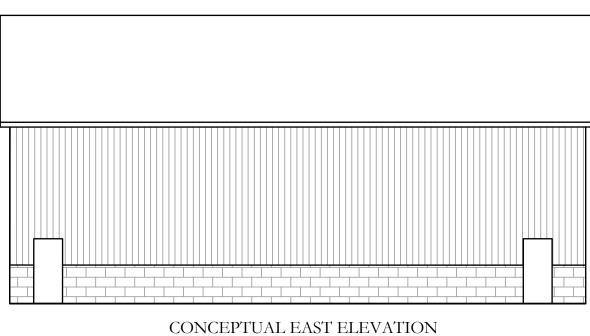


NOT TO SCALE

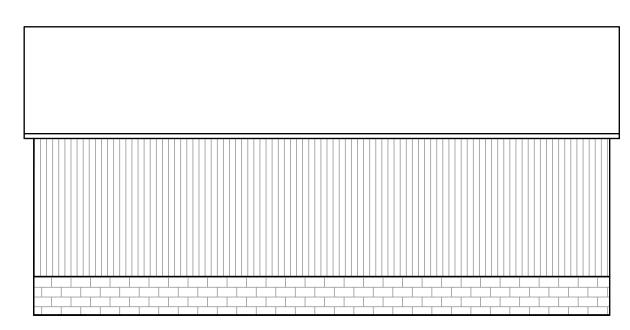

CONCEPTUAL WEST ELEVATION NOT TO SCALE

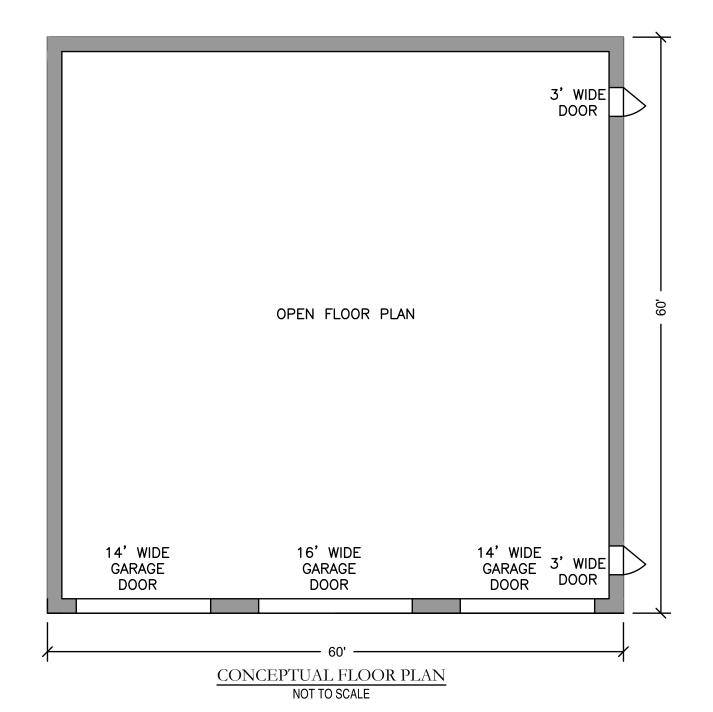

- 1. BUILDING BY MORTON BUILDINGS, INC, STYLE 306, 60'x18'x60'.
- 2. SEE ARCHITECTURAL PLANS/SPECIFICATIONS.
- 3. AT LEAST ONE KNOCK BOX TO BE PROVIDED FOR EMERGENCY ACCESS.

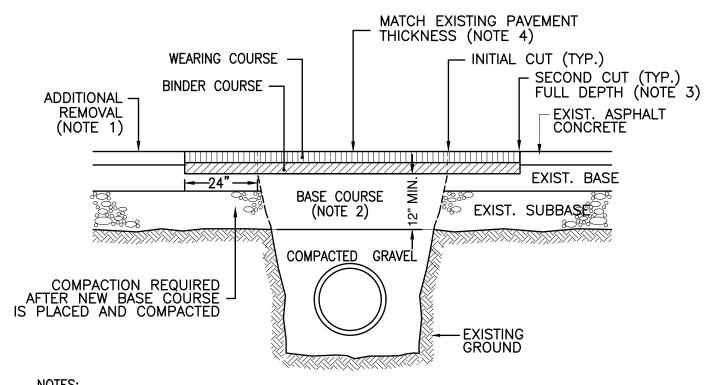


1. ADDITIONAL PAVEMENT REMOVAL - REMOVE ADDITIONAL PAVEMENT TO A PAINTED LANE STRIPE, A LIP OF GUTTER, A CURB, AN EXISTING PAVEMENT PATCH, OR AN EDGE OF THE PAVEMENT IF SUCH STREET FEATURE IS WITHIN 2' OF THE SECOND SAW CUT.


2. NEW BASE COURSE - PROVIDE BASE COURSE MATERIAL IN LIFTS NOT EXCEEDING 6" AFTER COMPACTION. COMPACT TO A MODIFIED PROCTOR DENSITY OF 95% OR GREATER.

3. TACK COAT - PROVIDE FULL TACK COAT COVERAGE ON ALL VERTICAL SURFACES.


4. NEW ASPHALT PAVEMENT - THICKNESS SHALL EITHER BE EQUIVALENT TO EXISTING CONDITION OR MEET DETAIL RS.01, WHICHEVER IS GREATER. COMPACT THE NEW PAVEMENT TO 96% OF LABORATORY DENSITY OR 94% OF MAXIMUM THEORETICAL DENSITY. INSTALL ASPHALT IN 2" LIFTS, MAXIMUM.

> SHALLOW EXCAVATION IN ASPHALT PAVEMENT (42" DEPTH OR LESS) NOT TO SCALE

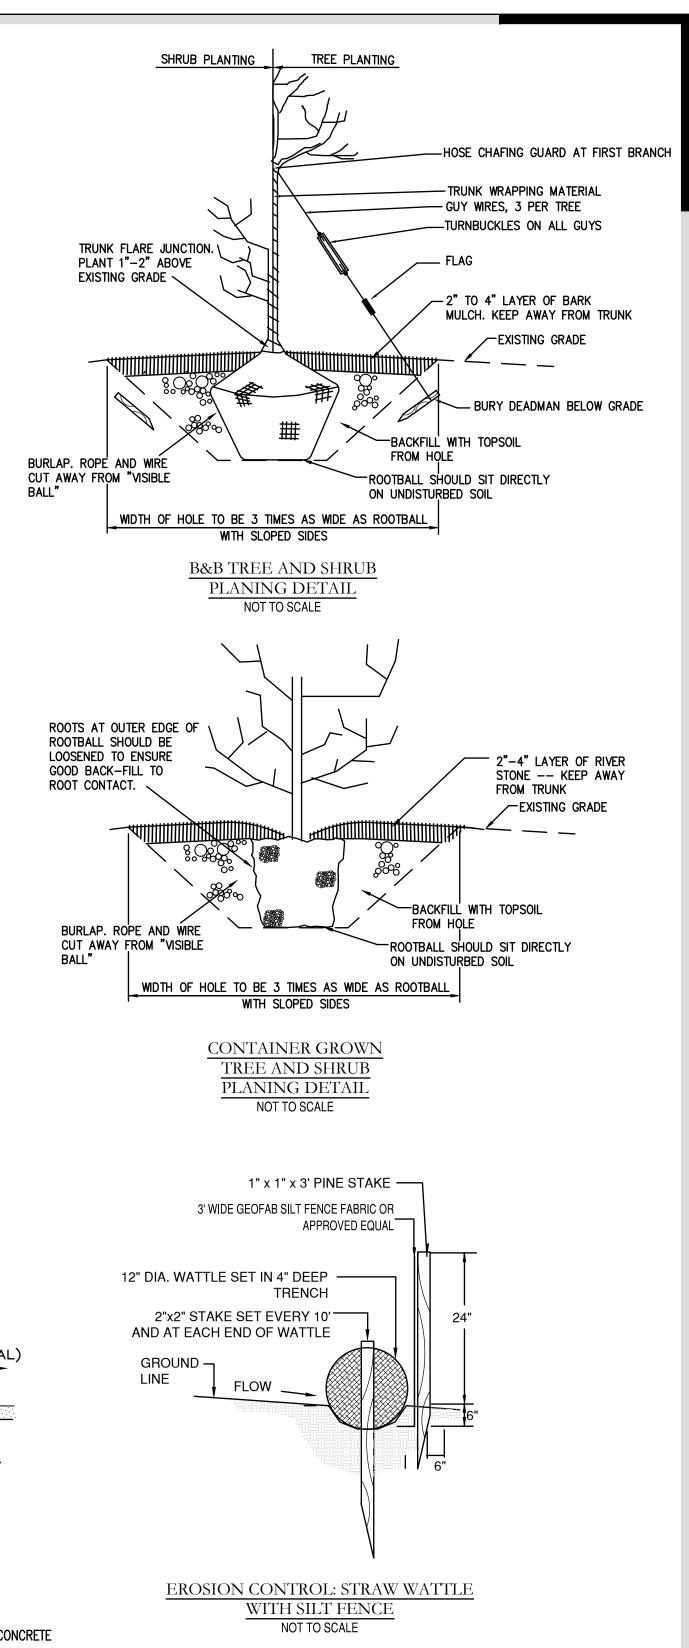


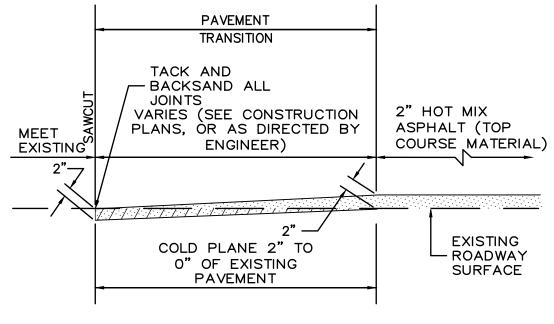

PAVEMENT TRANSITION NOT TO SCALE

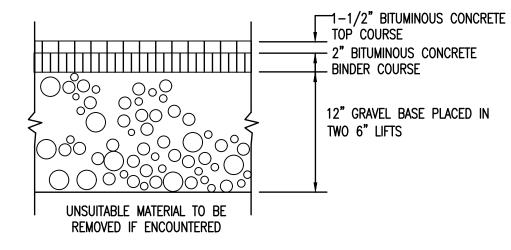

BITUMINOUS PAVEMENT NOT TO SCALE

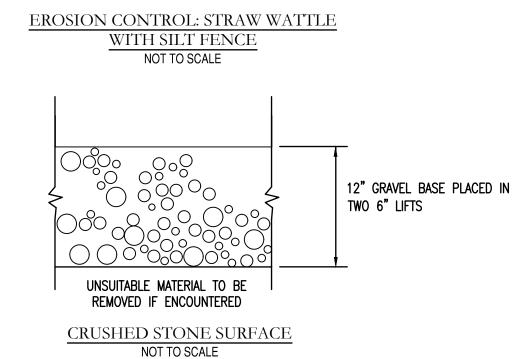


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TRUCK TURNING PLAN
SCALE: 1"=30'

EMERGENCY ACCESS NOTES:

- 1. A MINIMUM OF ONE KNOX BOX IS REQUIRED FOR THE PROPOSED BUILDING.
- EMERGENCY ACCESS TO ACCOMMODATE THE FOLLOWING SPECIFICATIONS AS PROVIDED BY THE TOWN OF BOURNE FIRE/RESCUE & EMERGENCY SERVICES:

TRUCK 125 SPECIFICATIONS

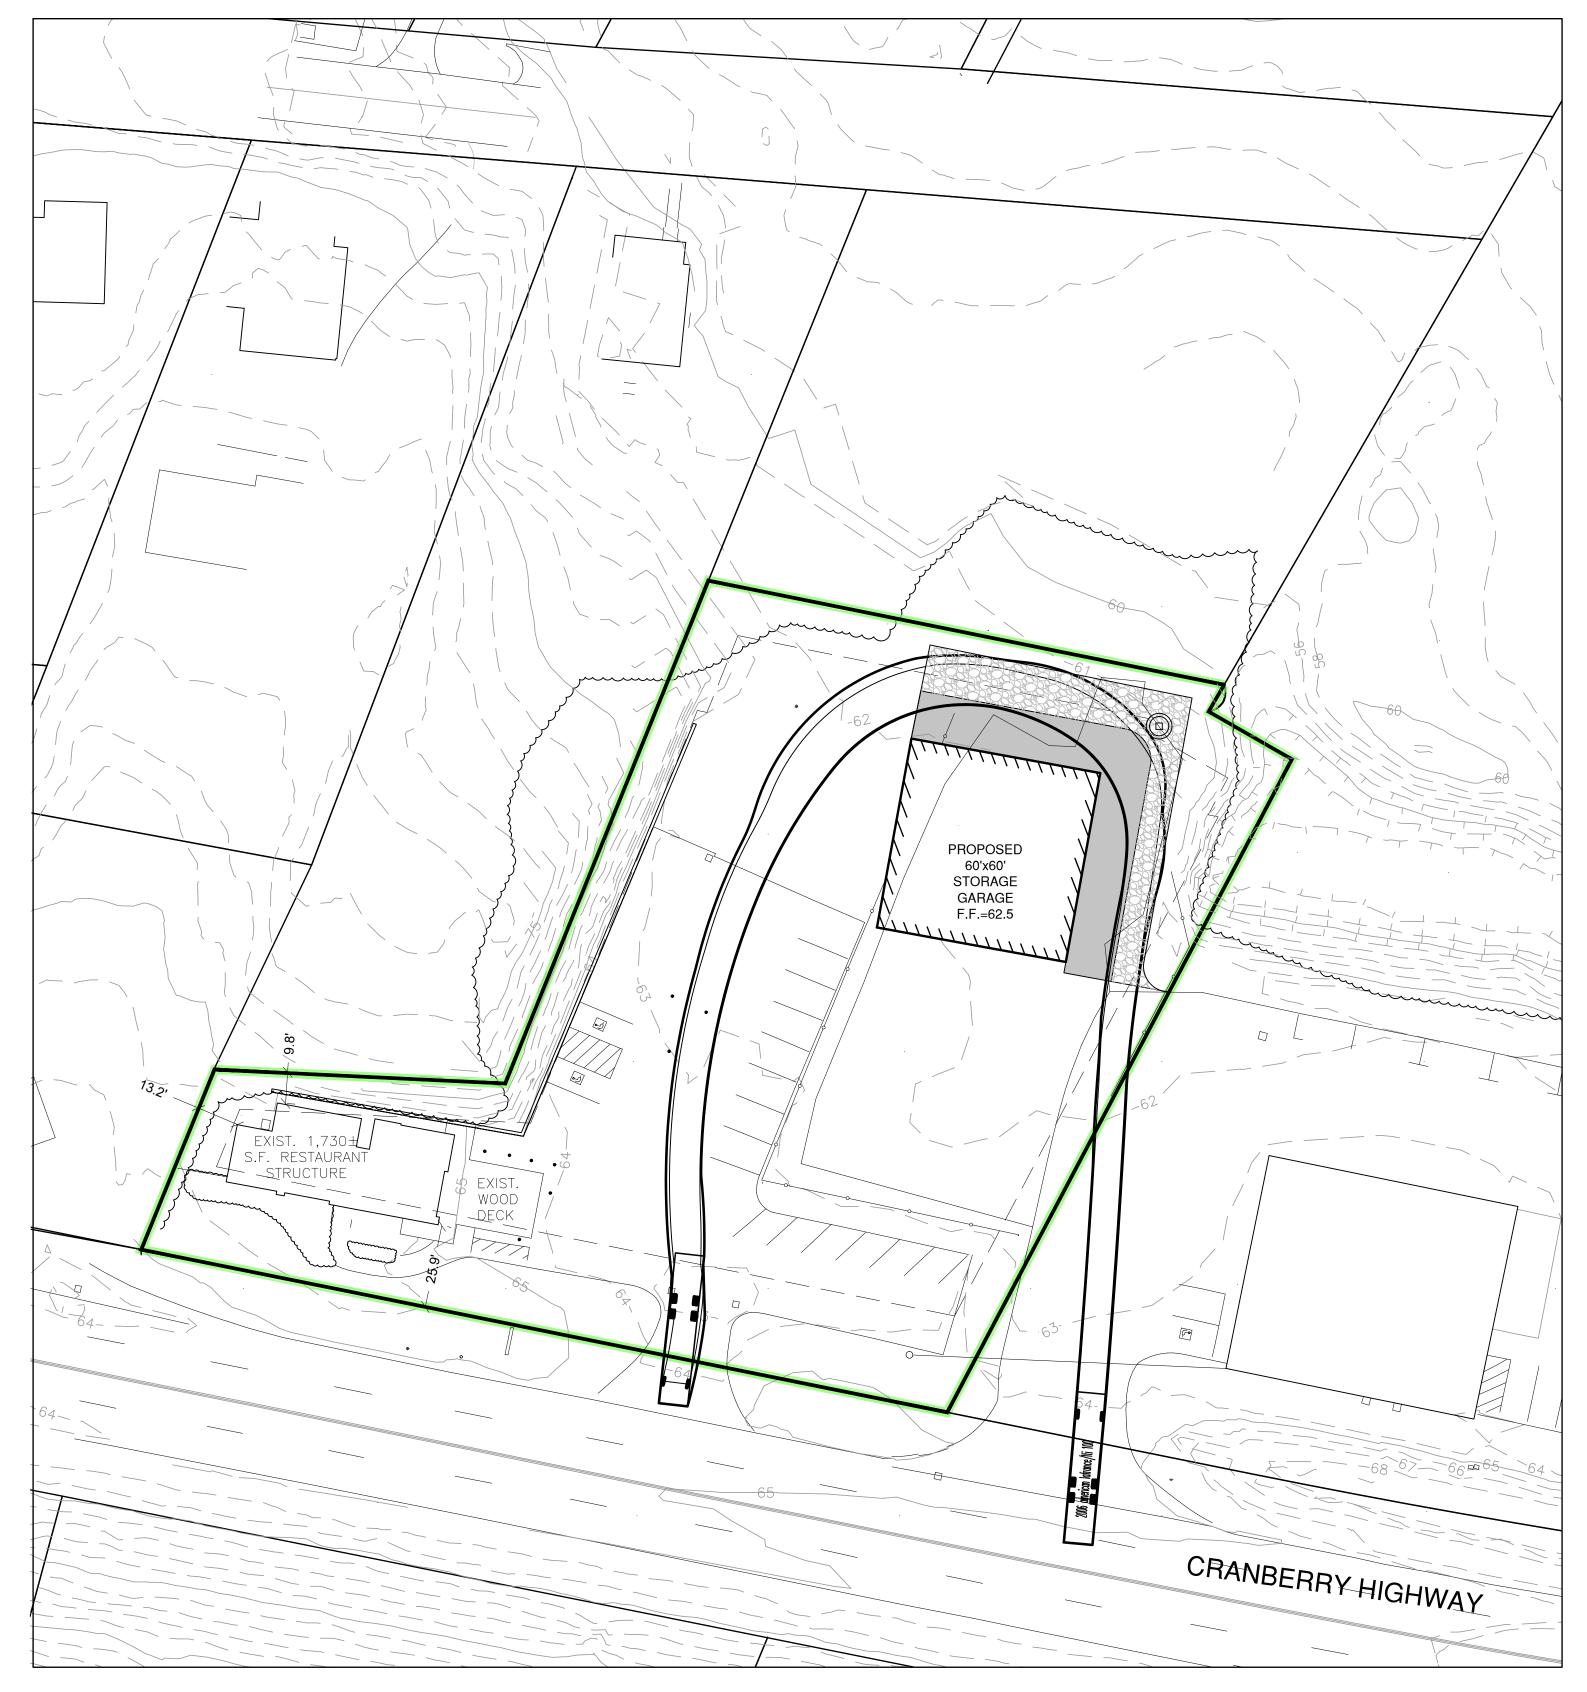2006 AMERICAN LAFRANCE/LTI 100' AERIAL TOWER LADDER TRUCK

- OVERALL LENGTH: 4 7 FEET, 2¾ INCHES
- HEIGHT: 11 FEET CENTER OF FRONT WHEEL TO FRONT OF TRUCK: 92 INCHES
- WHEELBASE: 255 INCHES
- FRONT BUMPER EXTENSION: 18 INCHES
- CENTER OF BETWEEN THE REAR WHEELS, TO THE REAR OF THE TRUCK: 199 .25 INCHES.
- THE BUCKET HANGS ABOUT 2 FEET BEYOND THE REAR OF THE TRUCK. WIDTH OF THE TRUCK: 9 FEET
- WIDTH OF THE TRUCK WITH THE OUTRIGGERS EXTENDED: 18 FEET
- WEIGHT OF THE TRUCK: 71,060 POUNDS
- MAXIMUM TURNING (CRAMP) ANGLE WITH ALL SELECTED WHEEL AND
- STEERING EQUIPMENT INSTALLED: 30°
- INSIDE TURNING RADIUS: 35.71 FEET
- CURB TO CURB TURNING RADIUS: 49 FEET
- WALL TO WALL TURNING RADIUS: 52.65 FEET

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SHEET NO. 5 of 5